
# LAKE ERIE METROPARK SHORELINE RESTORATION - PHASE II

Project No. 51218.239

NOAA Grant No. NA16NMF4630341

# HURON-CLINTON METROPARK AUTHORITY

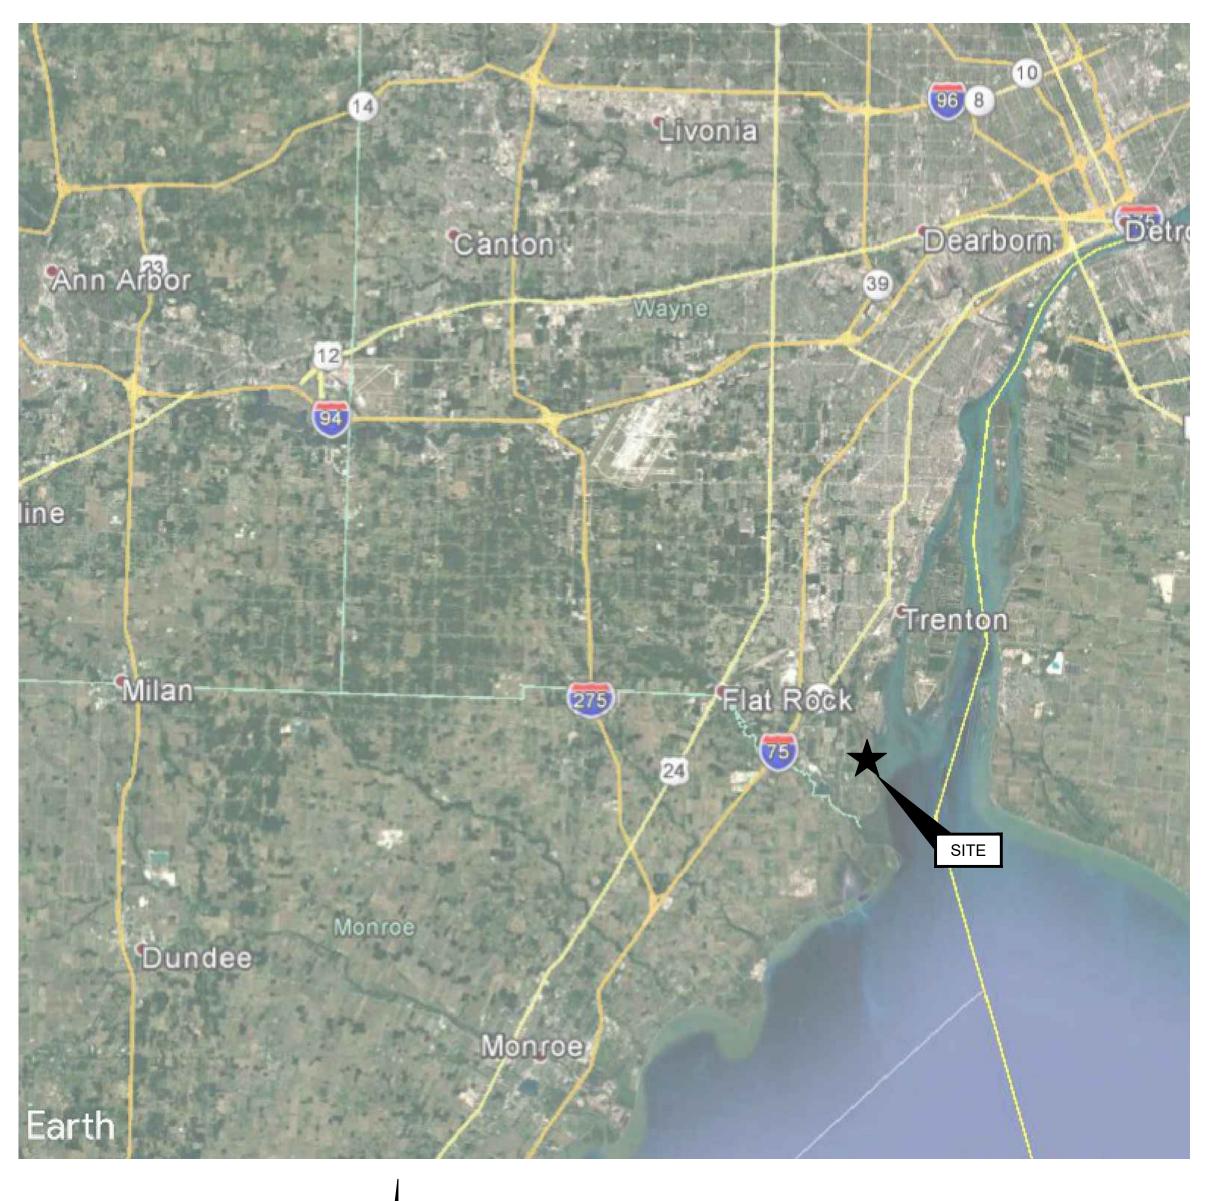



OWNER CONTACT: TYLER MITCHELL, CHIEF OF NATURAL RESOURCES AND REGULATORY COMPLIANCE

**SHEET INDEX** 

COVER SHEET NOTES SESC

**EXISTING SHORELIN** 

SITE DETAILS

PLANTING PLAN

LANDSCAPING DETAILS

HURON-CLINTON METROPARKS AUTHORITY, ADMINISTRATIVE OFFICE

13000 HIGH RIDGE DRIVE BRIGHTON, MI 48114-9058 USA (808) 321-2634

PLYMOUTH, MI 48170

**ENGINEER CONTACT:** SCOTT DIERKS, PE SENIOR WATER RESOURCE ENGINEER GEI CONSULTANTS 9282 GENERAL DRIVE, SUITE 180

#### **VICINITY MAP** SCALE: N.T.S.

# FOR CONSTRUCTION



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not original scale.	NO.	DATE	ISSUE/REVISION	APP

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P.E. Number:	44371	

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ULI	Consultants

HURON-CLINTON METROPARK AUTHORITY	

GEI Project 1903754

-CLINTON METROPARK	LAKE ERIE METROPARK SHORELINE RESTORATION	DWG. NO.
AUTHORITY		SHEET NO.
	COVER SHEET	1 of 10

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#### PROJECT, BASE BID AND ALTERNATE BID DESCRIPTIONS

- 1. SURVEY WAS COMPLETED BY SME; (11-1-2019). DRAWING BASED ON MICHIGAN STATE PLAN COORDINATES SYSTEM, SOUTH ZONE, INTERNATIONAL FEET. VERTICAL DATUM REFERENCED TO NAVD88. DRAWING BASED ON MICHIGAN STATE PLAN COORDINATES SYSTEM, SOUTH ZONE, INTERNATIONAL FEET. VERTICAL DATUM REFERENCED TO NAVD88. THIS SURVEY WILL NOT SHOW ALL EASEMENTS OF RECORD NO TITLE POLICY HAS BEEN FURNISHED TO THE SURVEYOR BY THE OWNER.
- 2. THIS IS THE SECOND PHASE OF A TWO-PHASE PROJECT. ORIGINALLY THERE WAS GOING TO BE APPROXIMATELY A YEAR BETWEEN THE CONCLUSION OF PHASE 1 AND INITIATION OF PHASE 2. DELAYS IN IMPLEMENTING PHASE ONE HAVE RESULTED IN THE PROJECTS OCCURRING BACK TO BACK. PHASE 1 CONSISTS PRIMARILY OF GRADING THE PROJECT SHORELINE BACK TO AN APPROXIMATELY 15:1 TO 20:1 GRADE, WHILE LEAVING THE EXISTING RIPRAP WALL IN PLACE.
- 3. FOR THIS PROJECT PHASE 2 THE CONTRACTOR SHALL EXCAVATE APPROXIMATELY 1,930-CY OF THE EXISTING RIPRAP BERM; STOCKPILE APPROXIMATELY 700-CY OF BERM RIPRAP AND GRAVEL WITH THE REMAINDER TO BE TRANSPORTED TO PARK SPOILS PILE AND ROUGH GRADED. CONSTRUCT EIGHT OFFSHORE RUBBLE MOUND BREAKWATERS WITH 860 TONS OF ~2-FT DIAMETER LIMESTONE BOULDERS; 352 TONS OF ~1-FT DIAMETER LIMESTONE BOULDERS AND 333 CYD OF 3"-6" DIAMETER AGGREGATE. SUITABLE STOCKPILED RIPRAP AND GRAVEL WILL BE USED TO MAKE UP SOME OF THIS TOTAL BREAKWATER STONE. ADDITIONALLY, PLACE AND CONSTRUCT 12 ROOTWAD HABITAT STRUCTURES AND 3 CONSTRUCTED DEPRESSIONS WITH APPROXIMATELY 4.5-TONS OF SLABSTONE FOR EACH DEPRESSION (18 TONS TOTAL) IN THE NEARSHORE AREA. CONSTRUCT 3 STONE LANDINGS WITH APPROXIMATELY 5.5 TONS OF MICHIGAN LIMESTONE LEDGESTONE PER LANDING (22 TONS TOTAL). ALL WORK AREAS, SPOIL PILE AND ACCESS AREAS SHALL BE LEVELED AND DISKED PRIOR TO COMPLETION. ALL SEEDING, PLANTING AND BLANKETING TO BE DONE BY THE OWNER.
- 4. THE PROJECT MUST BE COMPLETE AND THE CONTRACTOR FULLY DEMOBILIZED FROM THE SITE BY APRIL 30, 2023. THE COMPLETION DATE IS FIXED AND IS NOT NEGOTIABLE.
- 5. THE SITE SHALL BE AVAILABLE FOR WORK AFTER NOVEMBER 1. 2022 AND FOLLOWING COMPLETION OF PHASE 1 WORK. SEE PROJECT COORDINATION SECTION BELOW FOR MORE DESCRIPTION OF SITE COORDINATION BETWEEN PHASE 1 AND PHASE 2.
- 6. THE CONTRACTOR MUST PROVIDE 7-DAY NOTICE PRIOR TO STARTING WORK.
- 7. PERMITS SHALL BE ACQUIRED BY THE OWNER. WORK CANNOT START UNTIL ALL PERMITS ARE IN HAND; HOWEVER, OWNER SHALL NOT BE RESPONSIBLE FOR LATER PERMITS.
- 8. FOR THE BASE BID IT IS ASSUMED THAT THE CONTRACTOR SHALL ACCESS THE SITE WITH HEAVY EQUIPMENT AND BRING IN HEAVY MATERIALS, SUCH AS STONE, BY BARGE VIA THE WATER. THERE IS A BOAT LAUNCH JUST NORTH OF THE SITE THAT IS PART OF THE LAKE ERIE METROPARK. CONTRACTORS SHALL ASSUME FOR THEIR BID THAT THEY WILL BARGE OVER EQUIPMENT AND MATERIALS FROM THAT POINT OF ENTRY. ONCE EQUIPMENT AND MATERIALS ARE DELIVERED TO THE SITE CONTRACTOR WILL HAVE ACCESS AND STORAGE INSIDE THE SNOW FENCE AREA SHOWN ON THE PROJECT DRAWINGS. AS LONG AS THE TURBIDITY CURTAIN IS PROPERLY INSTALLED THE CONTRACTOR MAY WORK IN THE WATER DURING CONSTRUCTION.
- 9. FOR THE ALTERNATE THE CONTRACTOR SHALL ASSUME THEY WILL ACCESS THE SITE AND BRING IN HEAVY MATERIALS, SUCH AS STONE, OVERLAND VIA THE ACCESS ROUTES IDENTIFIED IN THE PROJECT DRAWINGS.

#### PROJECT COORDINATION NOTES

- 1. PHASE 1 CONTRACTOR IS RESPONSIBLE FOR EXCAVATING AND GRADING OUT THE NEW SHORELINE SLOPE BEHIND THE RIPRAP. THIS CONTRACTOR WILL ALSO BUILD AND MAINTAIN HAUL ROADS AND A SPOILS PILE ON PARK PROPERTY. THE PHASE 1 CONTRACTOR SHALL INSTALL AND MAINTAIN SNOW FENCE TO LIMIT CONSTRUCTION FOOTPRINT AND SILT FENCE TO LIMIT **EROSION IMPACTS.**
- 2. PHASE 1 CONTRACTOR SHALL LEAVE HAUL ROAD, SPOILS PILE, SNOW FENCE AND SILT FENCE IN PLACE AT THE CONCLUSION OF THEIR WORK. PHASE 1 CONTRACTOR WILL NOT BE RESPONSIBLE FOR RESTORATION OF THESE AREAS. CONTROL OF THE SITE SHALL PASS TO PHASE 2 CONTRACTOR AT THE CONCLUSION OF PHASE 1. ALL
- 3. AT THE CONCLUSION OF PHASE 1 HCMA AND THE ENGINEER SHALL ASSESS THE CONDITION OF THE SNOW FENCE, SILT FENCE AND HAUL ROAD. PHASE 1 CONTRACTOR SHALL PERFORM ANY NECESSARY REPAIRS TO LEAVE ALL MEASURES IN PLACE AND IN GOOD WORKING ORDER. IF THE CONTRACTOR HAS CAUSED DAMAGE TO INFRASTRUCTURE THE ENGINEER SHALL ASSESS AND DOCUMENT THE DAMAGE. PHASE 1 CONTRACTOR WILL EITHER REPAIR OR BE ASSESSED THE COST OF REPAIRS FOR ANY DAMAGE CAUSED BY THE CONTRACTOR OR SUBCONTRACTORS.
- 4. PHASE 2 CONTRACTOR SHALL ASSUME MAINTENANCE OF EXISTING SNOW FENCE AND SILT CURTAIN FOR WORK AREAS AFTER THE PHASE 1 CONTRACTOR HAS CONCLUDED WORK AND REMAINS RESPONSIBLE FOR ITS MAINTENANCE THROUGHOUT CONSTRUCTION. SNOW FENCE AND SILT FENCE SHALL BE LEFT IN PLACE THROUGH CONCLUSION OF PHASE 2 CONSTRUCTION.
- 5. PHASE 2 CONTRACTOR IS NOT RESPONSIBLE FOR SITE SEEDING AND PLANTING; HOWEVER, PHASE 2 CONTRACTOR WILL BE RESPONSIBLE FOR PLACING TOPSOIL OVER ALL DISTURBED AREAS AND SHALL DECOMPACT ALL WORK AREAS, INCLUDING HAUL ROADS TO THE SATISFACTION OF HCMA AND ENGINEER BEFORE MOBILIZING OFF-SITE.
- 6. REMOVAL OF SNOW FENCE AND SILT CURTAIN SHALL BE PERFORMED BY HCMA.

Warning:

#### SOIL EROSION AND SEDIMENTATION CONTROL NOTES

- 1. THE CONTRACTOR SHALL PROVIDE SUPPLEMENTAL EROSION CONTROL MEASURES, AS NEEDED, TO PREVENT OFF-SITE TRANSPORT OF EARTH, SEDIMENT AND DEBRIS.
- 2. AREAS TO REMAIN UNSTABILIZED FOR A PERIOD OF MORE THAN 30 DAYS SHALL BE TEMPORARILY SEEDED AND MULCHED. AREAS TO REMAIN UNSTABILIZED FOR A PERIOD OF MORE THAN 30 DAYS SHALL BE TEMPORARILY SEEDED AND MULCHED.
- 3. PERMANENT SEEDING SHALL BE OCCUR BETWEEN MARCH 1 AND JUNE 15, OR BETWEEN AUGUST 15 AND OCTOBER 15.
- 4. ALL STOCKPILE AREAS SHALL BE SURROUNDED BY EROSION CONTROL BARRIERS UNTIL SUCH TIME AS THE MATERIAL IS RESPREAD AND STABILIZED OR TRANSPORTED OFF-SITE.
- 5. SOILS TO BE STOCKPILED FOR A PERIOD OF MORE THAN 30 DAYS SHALL BE SURROUNDED BY EROSION CONTROLS, TEMPORARILY SEEDED AND MULCHED.
- 6. TEMPORARY STOCKPILES OF DREDGED/EXCAVATED MATERIAL SHALL BE LOCATED ON-SITE, WITHIN THE DESIGNATED AREA(S). ANY MATERIAL NOT RE-USED ON-SITE SHALL BE TRUCKED TO AN ACCEPTABLE OFF-SITE DISPOSAL LOCATION IN ACCORDANCE WITH THE PROJECTS PERMITS.
- 7. EROSION CONTROL MEASURES SHALL BE INSPECTED DAILY AND DURING AND AFTER EVERY RAIN EVENT. ANY NECESSARY REPLACEMENT OR REPAIR SHALL BE PERFORMED PROMPTLY BY THE CONTRACTOR.
- 8. DUST SHALL BE CONTROLLED IN ACCORDANCE WITH THE SPECIFICATIONS AND APPLICABLE REGULATIONS.
- 9. THE CONTRACTOR SHALL ENSURE THAT ALL ACTIVE SHORELINE CONSTRUCTION ACTIVITY IS COMPLETELY ENCLOSED WITH SUITABLE TURBIDITY CURTAIN.
- 10.THE SITE SHALL BE LEFT IN A STABLE CONDITION AT THE CLOSE OF EACH DAY. THE SITE SHALL BE LEFT IN A STABLE CONDITION AT THE CLOSE OF EACH DAY.

#### CONSTRUCTION NOTES

- 1. THE CONTRACTOR SHALL NOTIFY ALL APPROPRIATE AGENCIES AND UTILITY COMPANIES, IN WRITING, 48 HOURS PRIOR TO ANY WORK WITHIN 15 FEET OF A UTILITY LINE.
- 2. THE CONTRACTOR SHALL, UNDER THE DIRECTION OF THE ENGINEER, ESTABLISH/MAINTAIN "CONSTRUCTION LIMITS" ON THE SITE BY ACCEPTABLE VISIBLE MARKERS ALL WORK AND EQUIPMENT SHALL BE CONFINED WITHIN THESE LIMITS, UNLESS OTHERWISE SPECIFICALLY AUTHORIZED.
- 3. NO CHANGES ARE TO BE MADE UNLESS AUTHORIZED BY ENGINEER AND/OR APPLICANT/OWNER.
- 4. THE CONTRACTOR SHALL COMPLY WITH ALL APPLICABLE FEDERAL, STATE AND LOCAL SAFETY CODES, REGULATIONS, LEGAL REQUIREMENTS, PERMIT CONDITIONS, ETC.
- 5. THE CONTRACTOR SHALL TAKE ADEQUATE PRECAUTIONS TO PROTECT ALL WALKS. STREETS, PAVEMENTS, HIGHWAY GUARDS, CURBING, EDGING, TREES, PLANTINGS, STRUCTURES, PIPES. ETC ON OR OFF THE PREMISES, AND SHALL REPAIR AND REPLACE OR OTHERWISE MAKE GOOD AT HIS/HER OWN EXPENSE AS REQUIRED BY THE ENGINEER OR OWNER ANY ITEMS DAMAGED AS A RESULT OF THE CONTRACTOR'S WORK.
- 6. THE CONTRACTOR SHALL DISPOSE OF ALL STUMPS, RUBBISH AND DEBRIS IN ACCORDANCE WITH THE SPECIFICATIONS AND ALL APPLICABLE CODES AND REGULATIONS. THE CONTRACTOR SHALL LEAVE THE PROJECT SITE IN SAFE AND CLEAN CONDITION UPON COMPLETION OF DREDGING OPERATIONS
- 7. THE CONTRACTOR SHALL PROVIDE ADEQUATE BRACING AND SHORING OF EXCAVATIONS IN ACCORDANCE WITH THE REQUIREMENTS OF ALL GOVERNING CODES AND REGULATIONS.
- 8. WORK SHALL COMPLY WITH APPLICABLE MUNICIPAL. STATE. AND FEDERAL PERMITS AND REQUIREMENTS.
- 9. THE CONTRACTOR SHALL OBTAIN AND COMPLY WITH ALL AUTHORIZATIONS NECESSARY FOR CONSTRUCTION AND SPOILS MATERIAL TRANSPORT VEHICLE ENTRY/EXIT/TRAVEL ON STATE AND LOCAL ROADS.

#### **UTILITY NOTES**

- 1. BEFORE COMMENCEMENT OF DREDGING, THE CONTRACTOR SHALL BE SOLELY RESPONSIBLE FOR MAKING ALL NECESSARY ARRANGEMENTS AND AND FOR PERFORMING ANY NECESSARY WORK INVOLVED IN CONNECTION WITH THE DISCONTINUANCE OR JURISDICTION OF THE UTILITY COMPANIES, SUCH AS ELECTRICITY, TELEPHONE, WATER, GAS AND ANY SYSTEM OR SYSTEMS WHICH WILL BE AFFECTED BY THE WORK TO BE PERFORMED UNDER THIS CONTRACT.
- 2. UNLESS OTHERWISE NOTED OR APPROVED BY THE ENGINEER OR OWNER, THE CONTRACTOR SHALL MAINTAIN ALL EXISTING UTILITIES.
- 3. IF REQUIRED, OVERHEAD LINES SHALL BE RELOCATED BY THE UTILITY COMPANY AT THE CONTRACTOR'S EXPENSE.
- 4. WHERE AN EXISTING UTILITY IS FOUND TO CONFLICT WITH THE PROPOSED WORK, THE LOCATION, ELEVATION AND SIZE OF THE UTILITY SHALL BE ACCURATELY DETERMINED WITHOUT DELAY BY THE CONTRACTOR AND THE INFORMATION FURNISHED TO THE ENGINEER AND OWNER FOR RESOLUTION OF THE CONFLICT.

#### FOR CONSTRUCTION



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Drawn:	MS, HC	
Submitted By:	SD	
P.E. Number:	44371	



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HURON-CLINTON METROPARK
AUTHORITY

GEI Project 1903754

	DWG. NO.
LAKE ERIE METROPARK SHORELINE RESTORATION	N1
	SHEET NO.
NOTES	2 of 10



EX. MAJ. CONTOUR ———————

EX. MIN. CONTOUR -----

FOR MORE DETAIL ON PROJECT DESCRIPTION, PROJECT COORDINATION, CONDITIONS, AND EXPECTATIONS OF THE CONTRACTOR BASED ON THE TRANSITION FROM PHASE 1 OF THIS PROJECT TO THIS PHASE (PHASE 2), SEE SHEET N1.

# FOR CONSTRUCTION

DWG. NO.

C1

SHEET NO.

3 of 10



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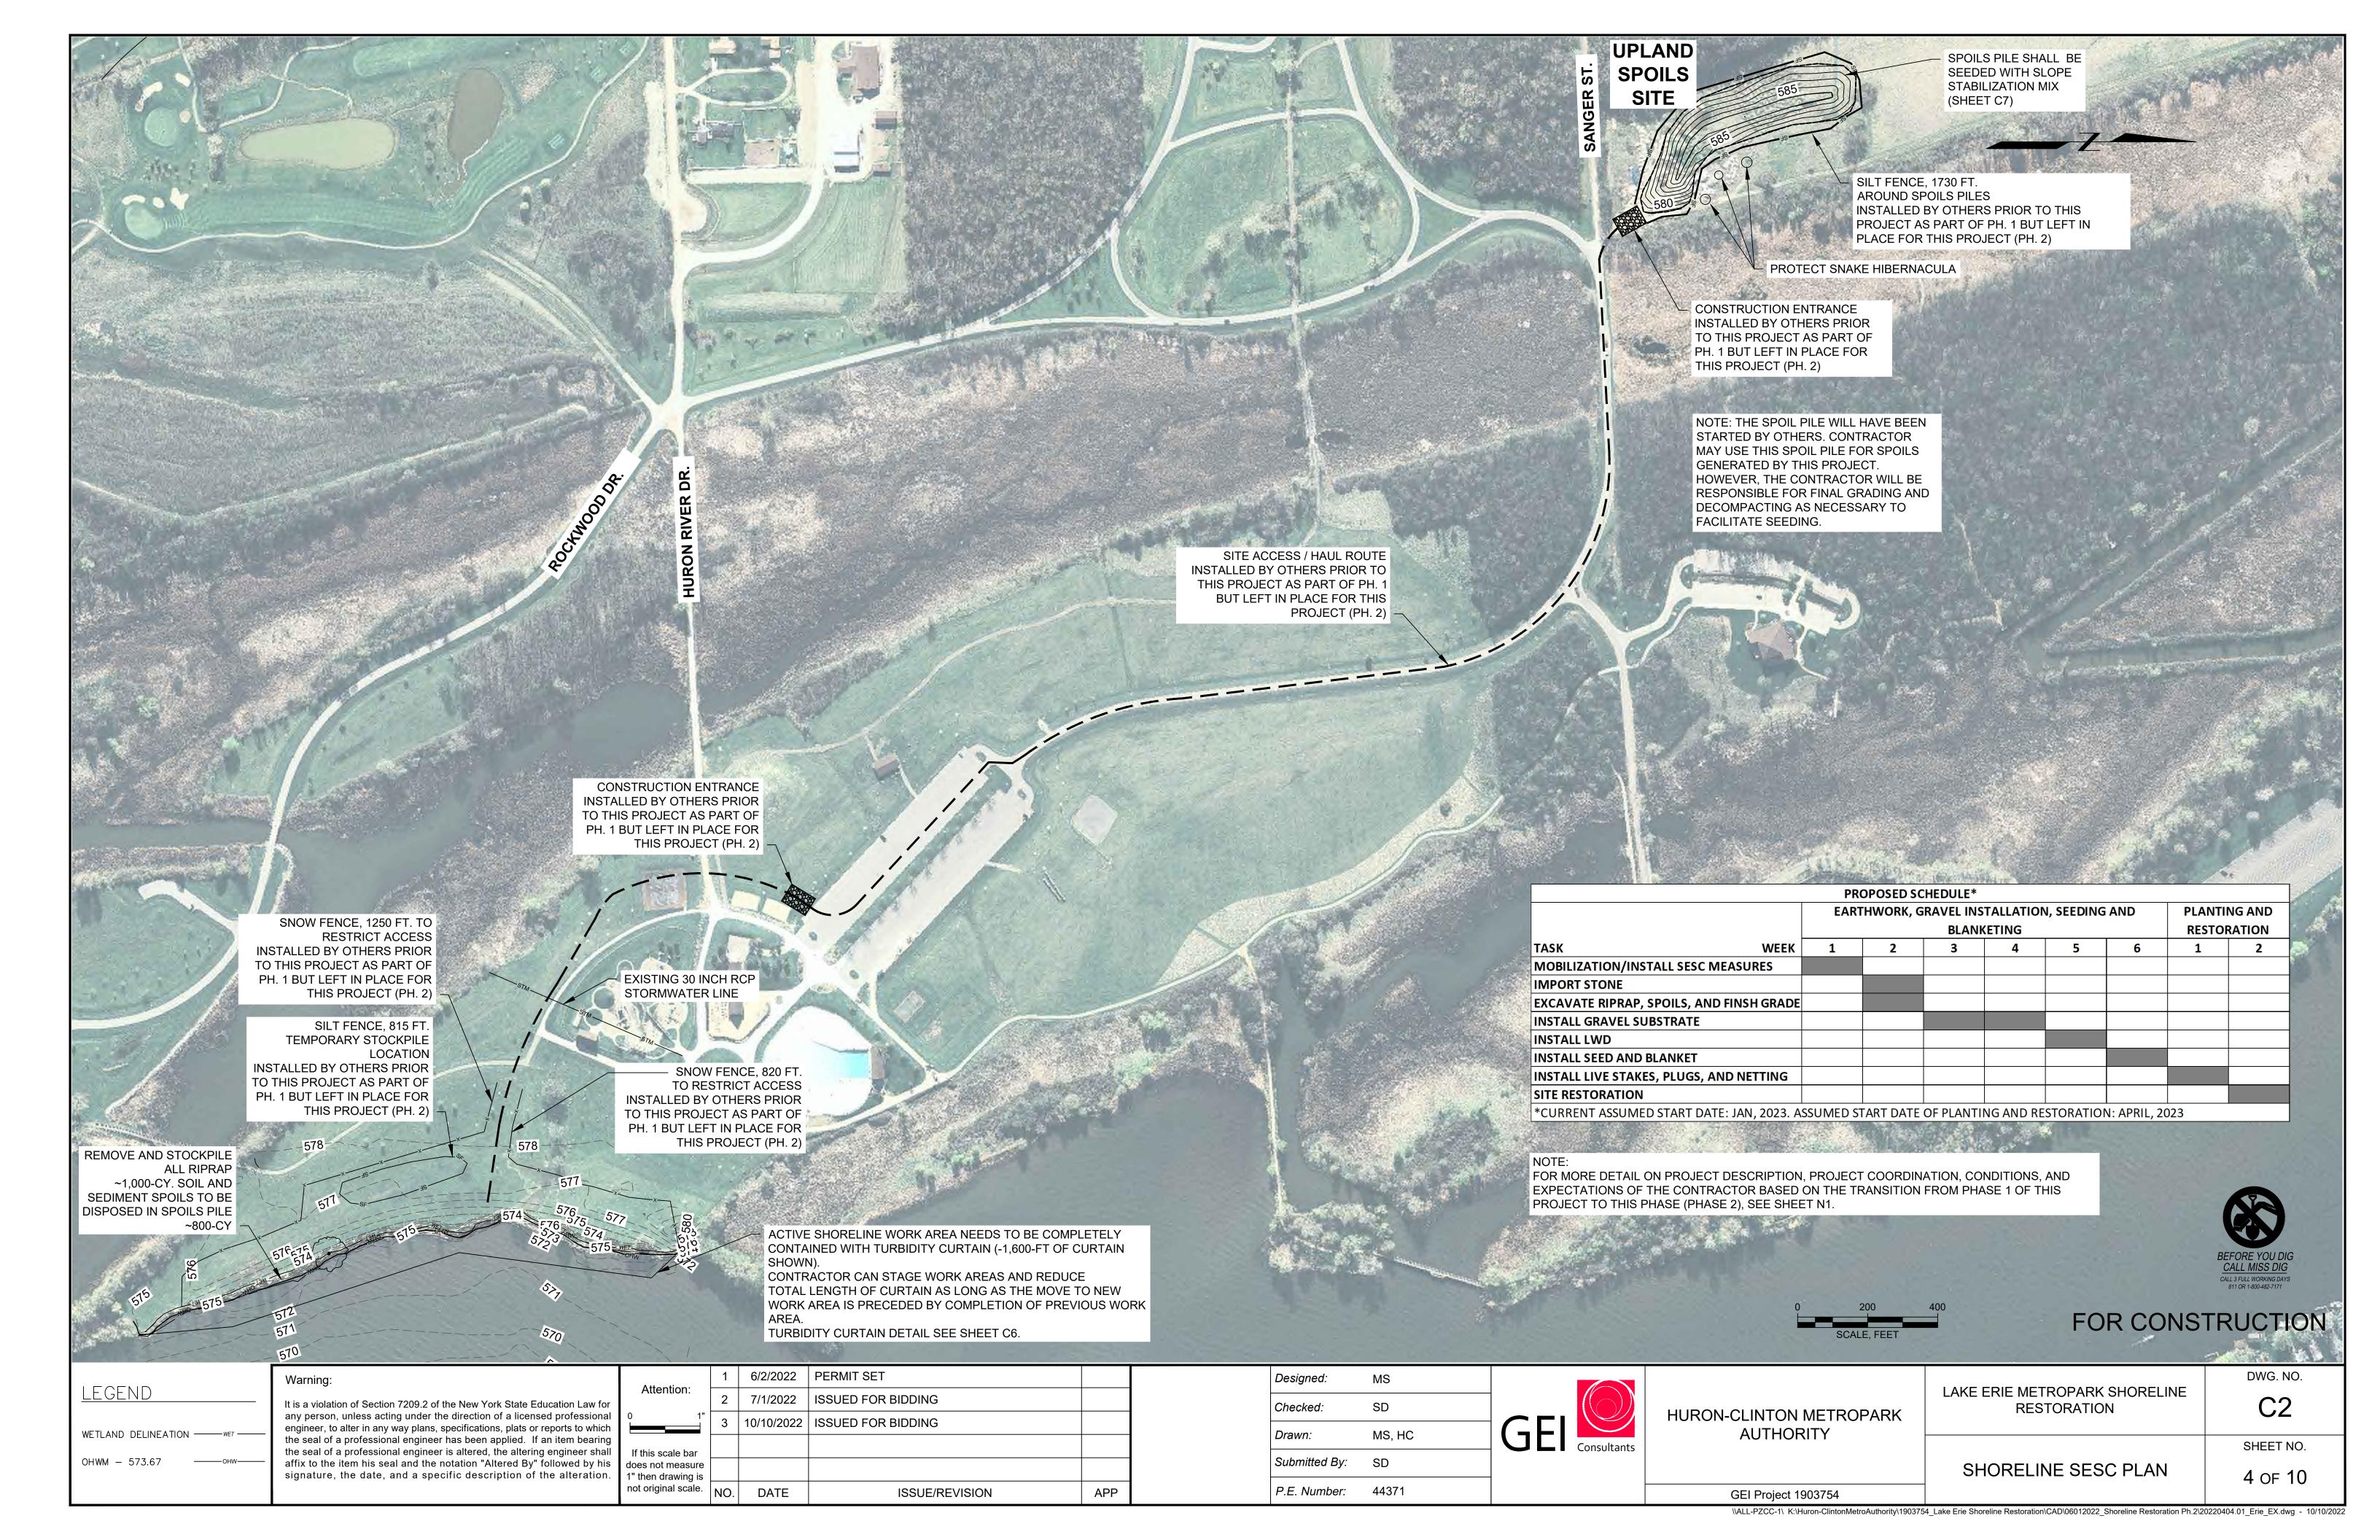



HURON-CLINTON METROPARK AUTHORITY

LAKE ERIE METROPARK SHORELINE RESTORATION

EXISTING CONDITIONS

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SHEET NO.

5 of 10

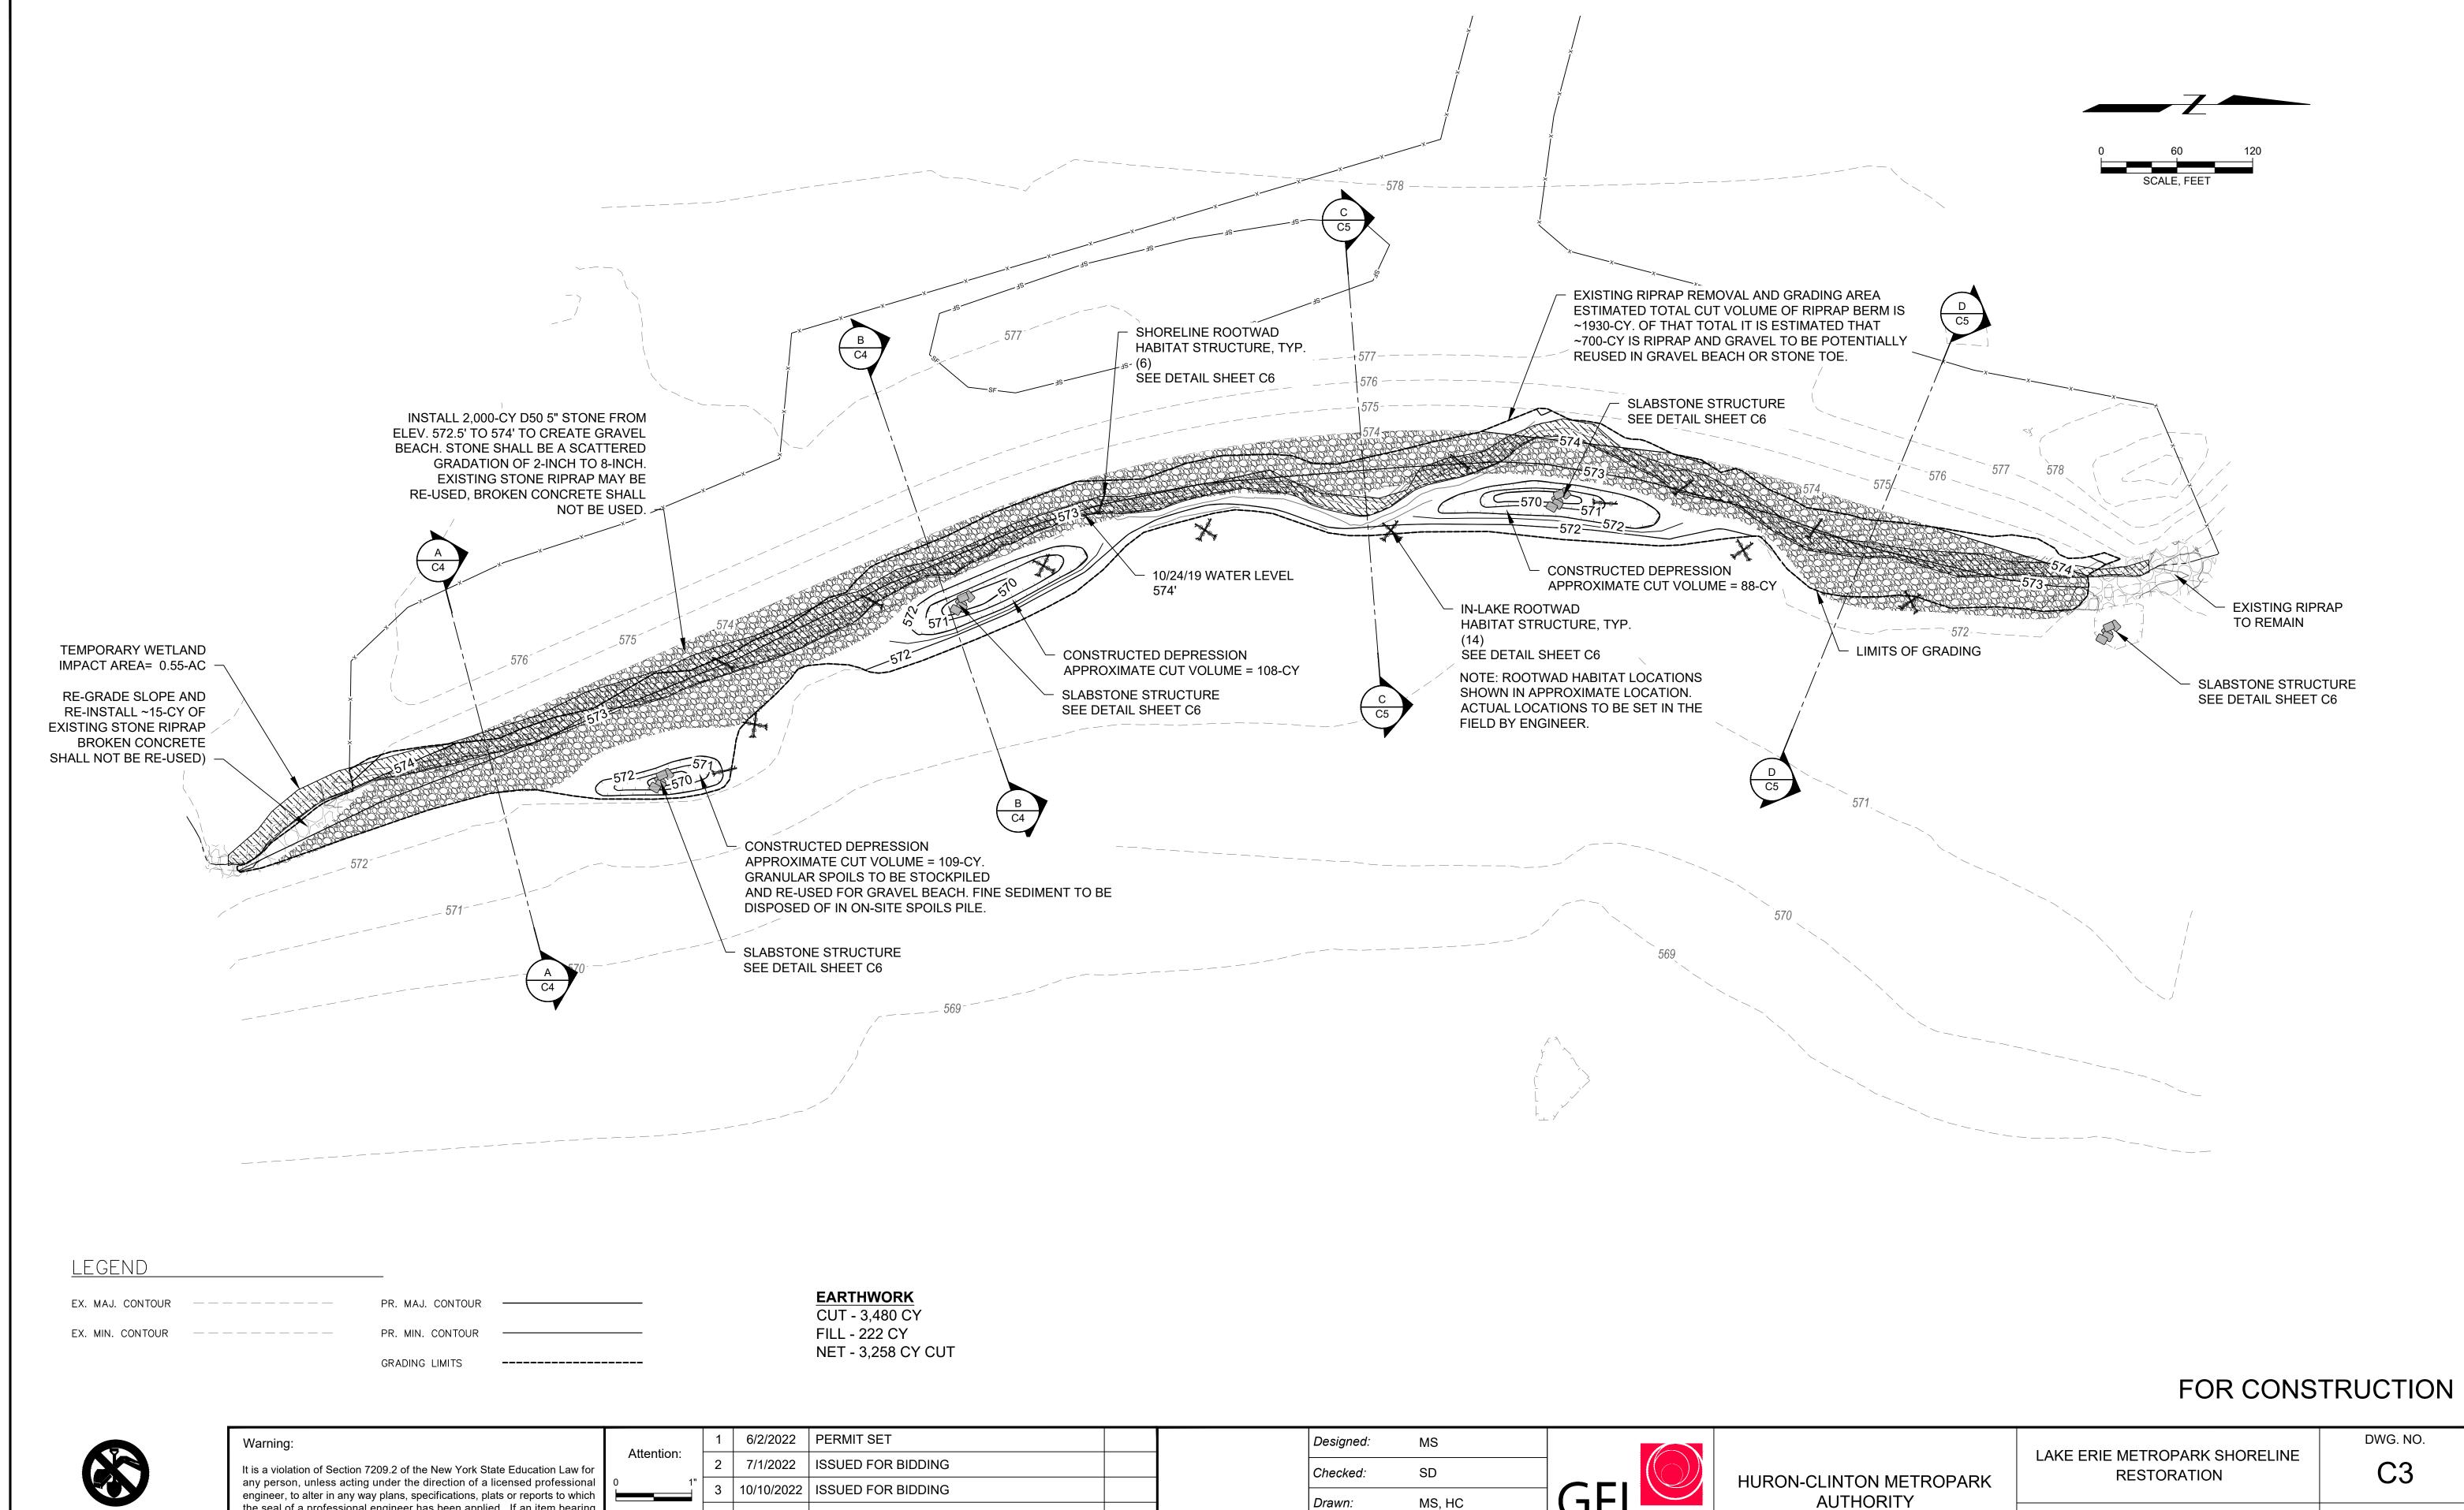SHORELINE GRADING PLAN

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GEI Project 1903754

BEFORE YOU DIG CALL MISS DIG CALL 3 FULL WORKING DAYS 811 OR 1-800-482-7171

the seal of a professional engineer has been applied. If an item bearing

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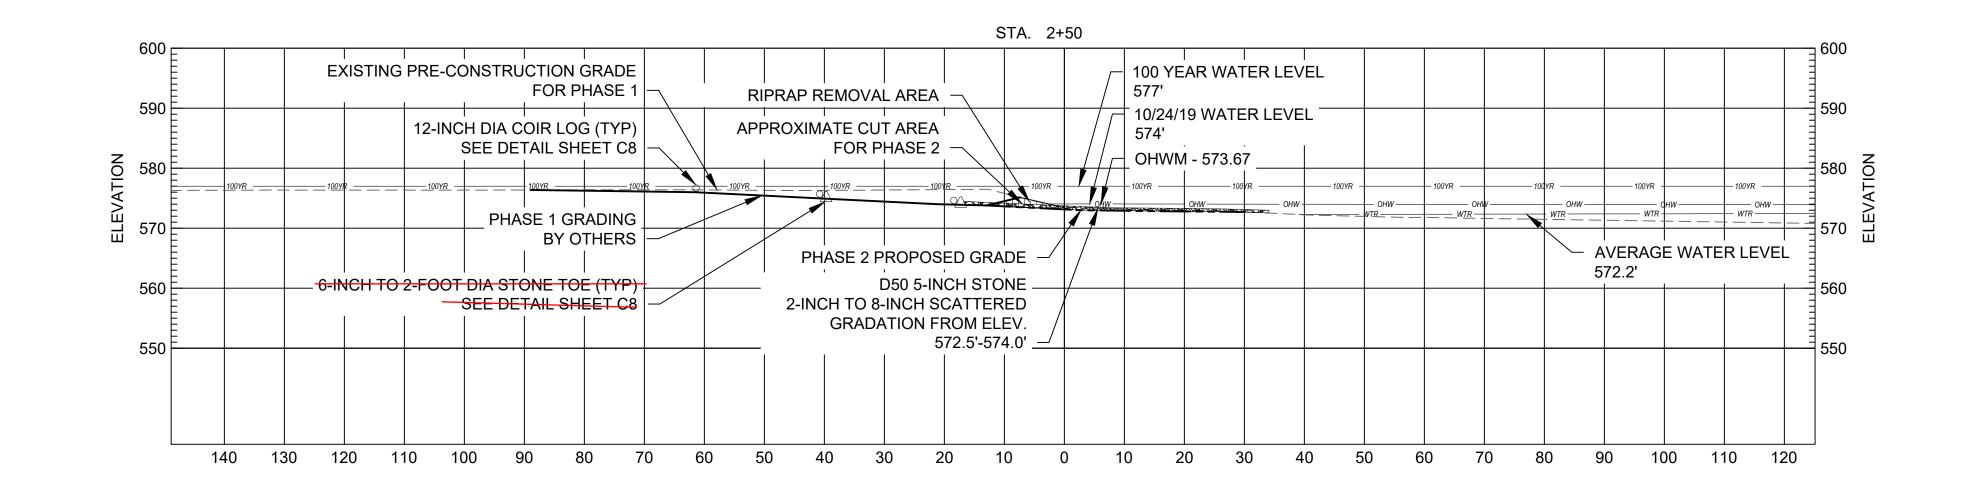
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LEGEND

**EXISTING PRE-CONSTRUCTION GRADE** 

EXISTING PHASE 1 GRADING

—--- PROPOSED PHASE 2 GRADING


PHASE 2 EXCAVATION AREA

D50 5-INCH STONE

—— 100YEAR FLOOD ELEVATION

SURVEYED WATER ELEVATION



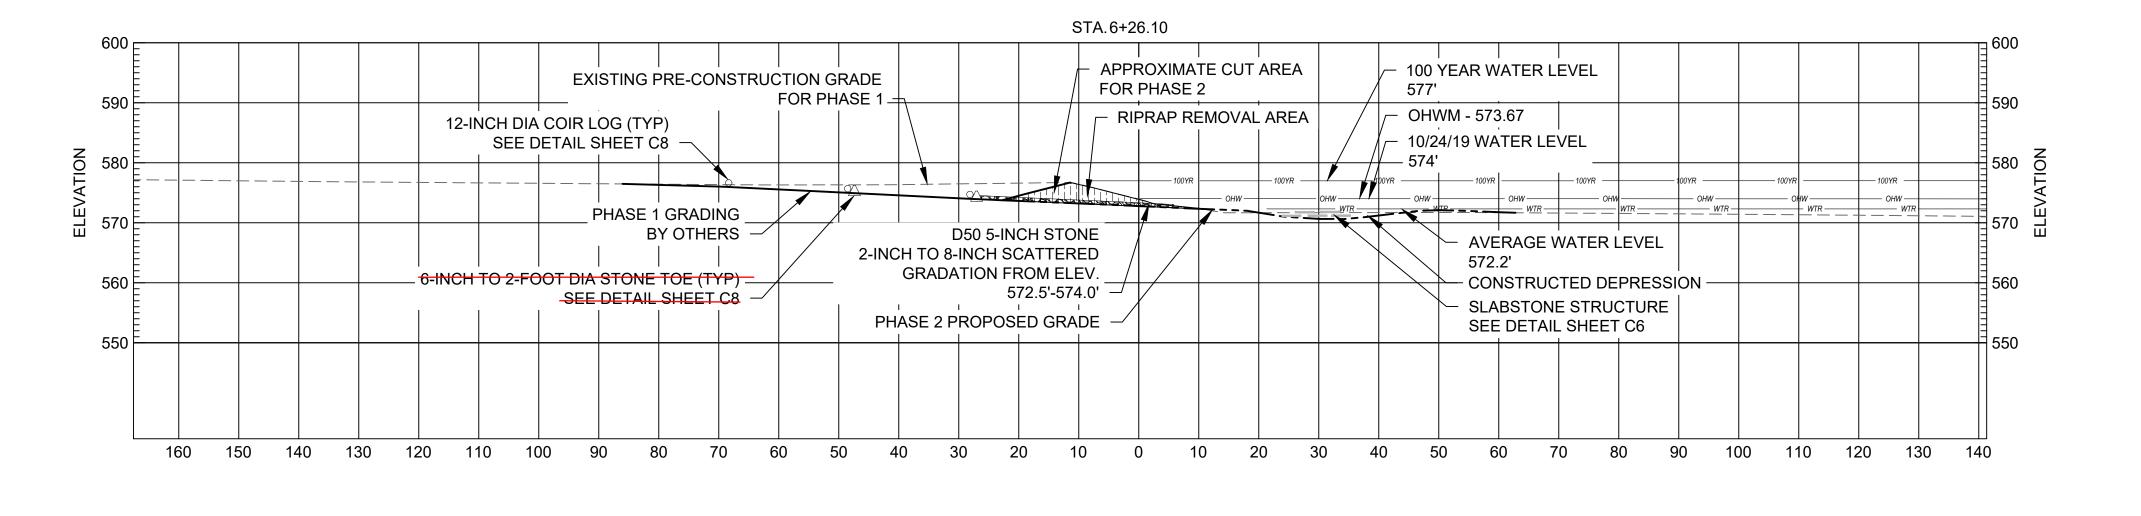

**SECTION VIEW** 

# FOR CONSTRUCTION

DWG. NO.

C4

SHEET NO.

6 of 10



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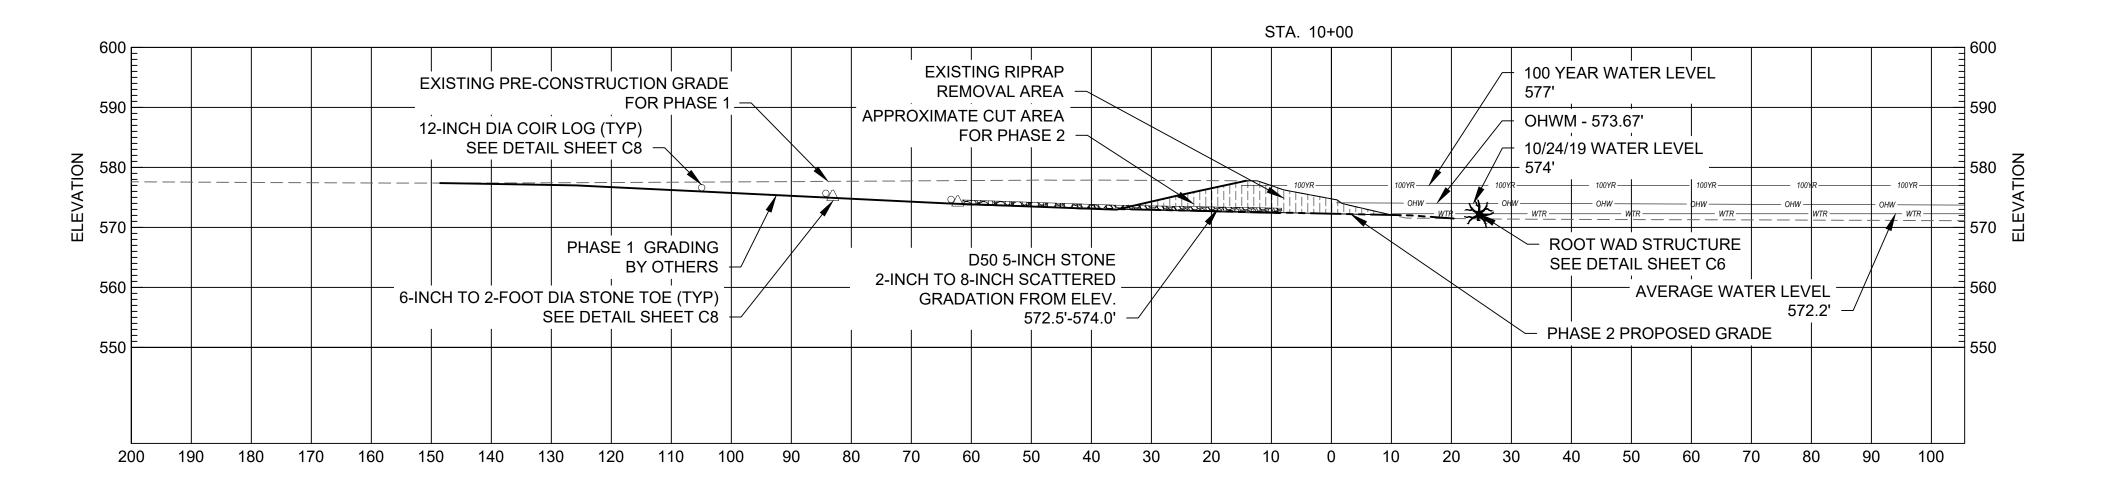
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LEGEND

**EXISTING PRE-CONSTRUCTION GRADE** 

**EXISTING PHASE 1 GRADING** 

—--— PROPOSED PHASE 2 GRADING

PHASE 2 EXCAVATION AREA


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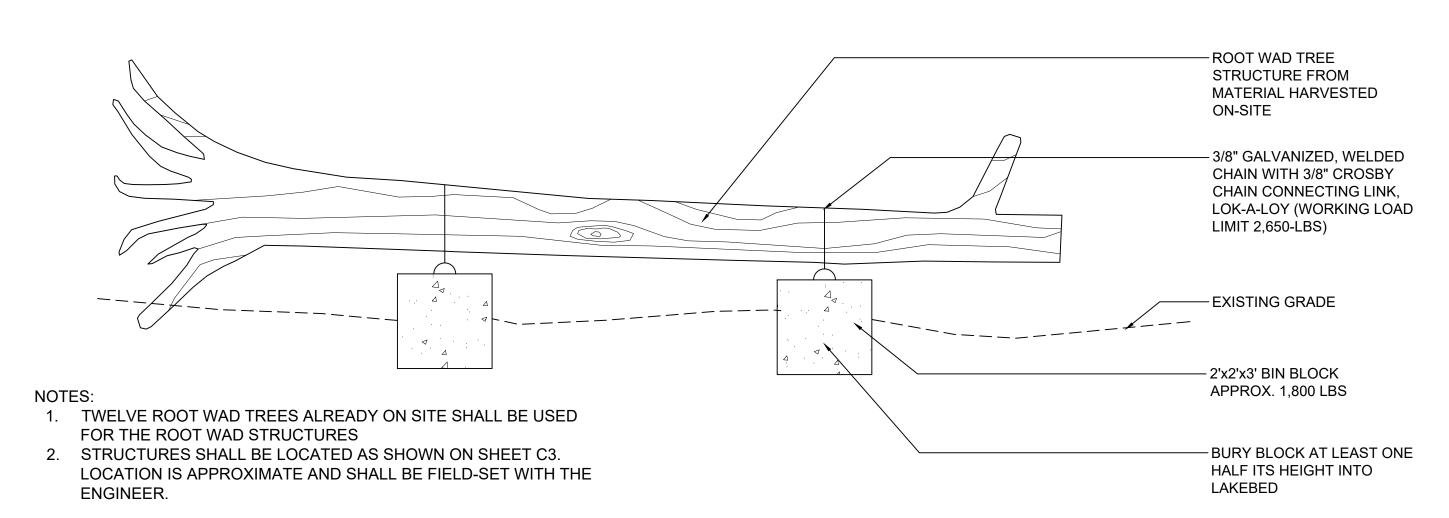


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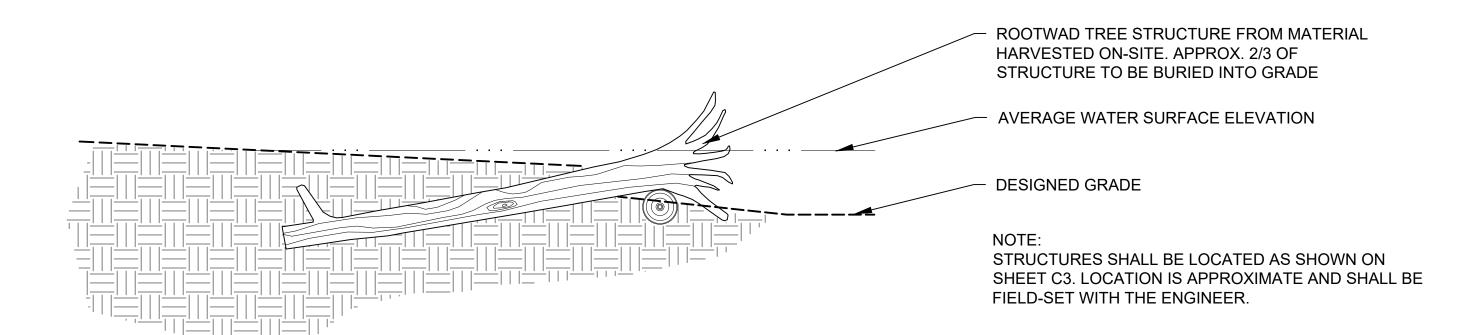
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AUTHORITI	CHODELINE	SHEET NO.
	SHORELINE SECTIONS	7 of 10

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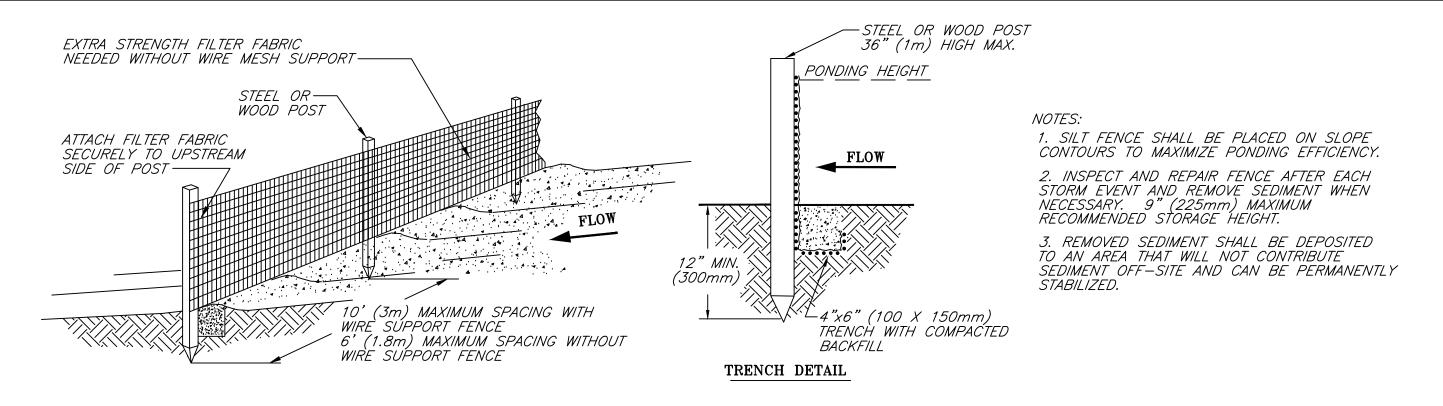


### IN-LAKE ROOT WAD HABITAT STRUCTURE

NOT TO SCALE

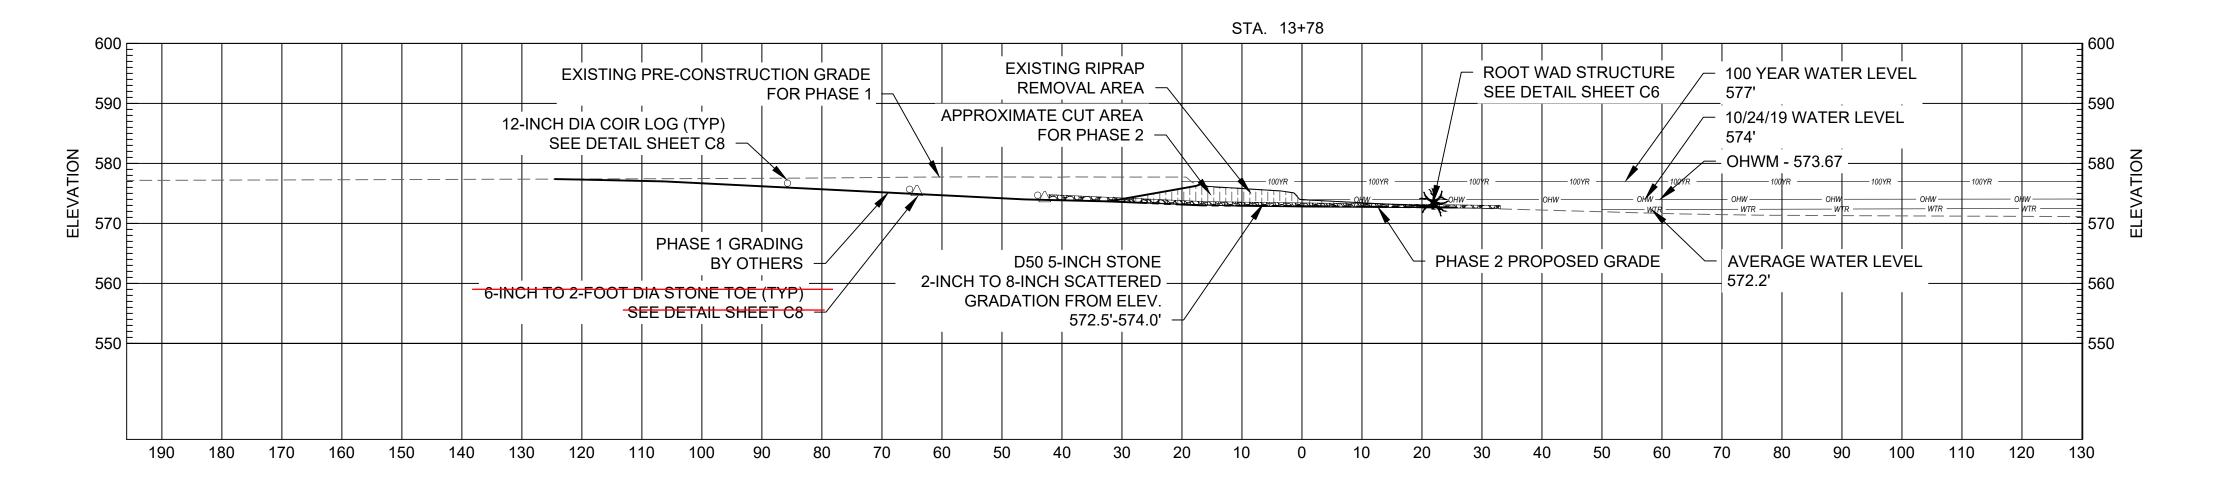



### SHORELINE ROOT WAD HABITAT STRUCTURE



### **SILT FENCE**


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A All dimensions are in millimeters unless otherwise shown.
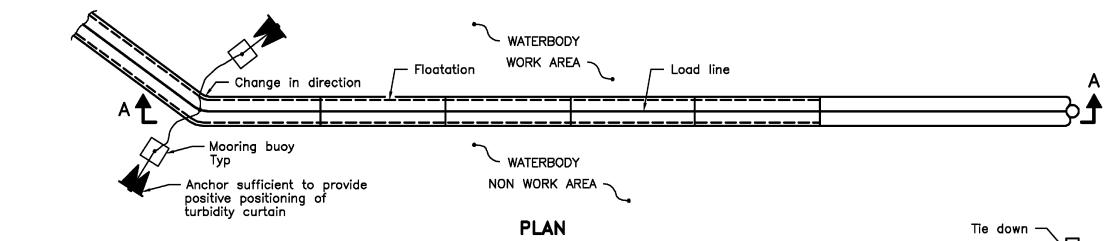
# **TURBIDITY CURTAIN**

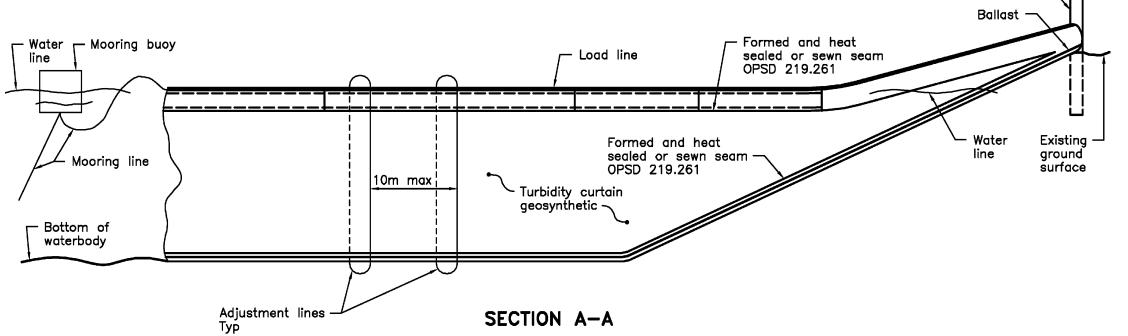


**GRAVEL CONSTRUCTION ENTRANCE** 

NOT TO SCALE

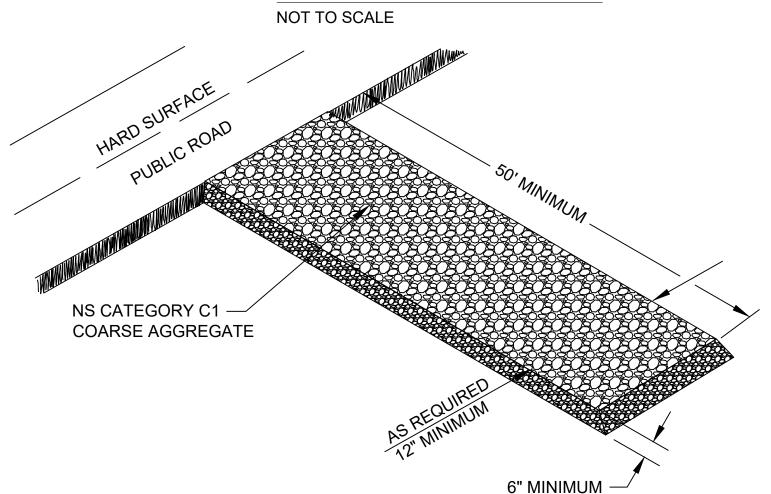6 TONS OF ROCK REQUIRED PER STRUCTURE.

SIZE AND QUANTITY OF SLABS WILL VARY. 2. SLABS ARE TO BE PLACED RANDOMLY, CREATING VOID SPACES BY LAYERING SLABS ATOP ONE

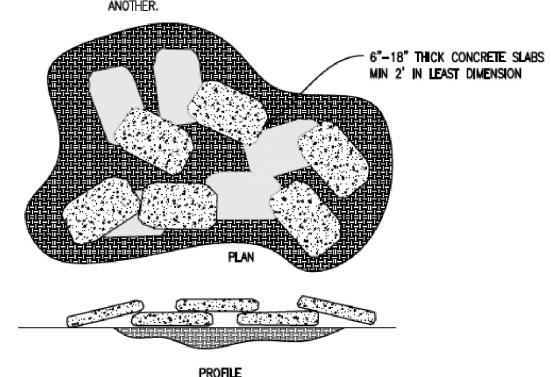

# **SLABSTONE STRUCTURE**

NOT TO SCALE

FOR CONSTRUCTION



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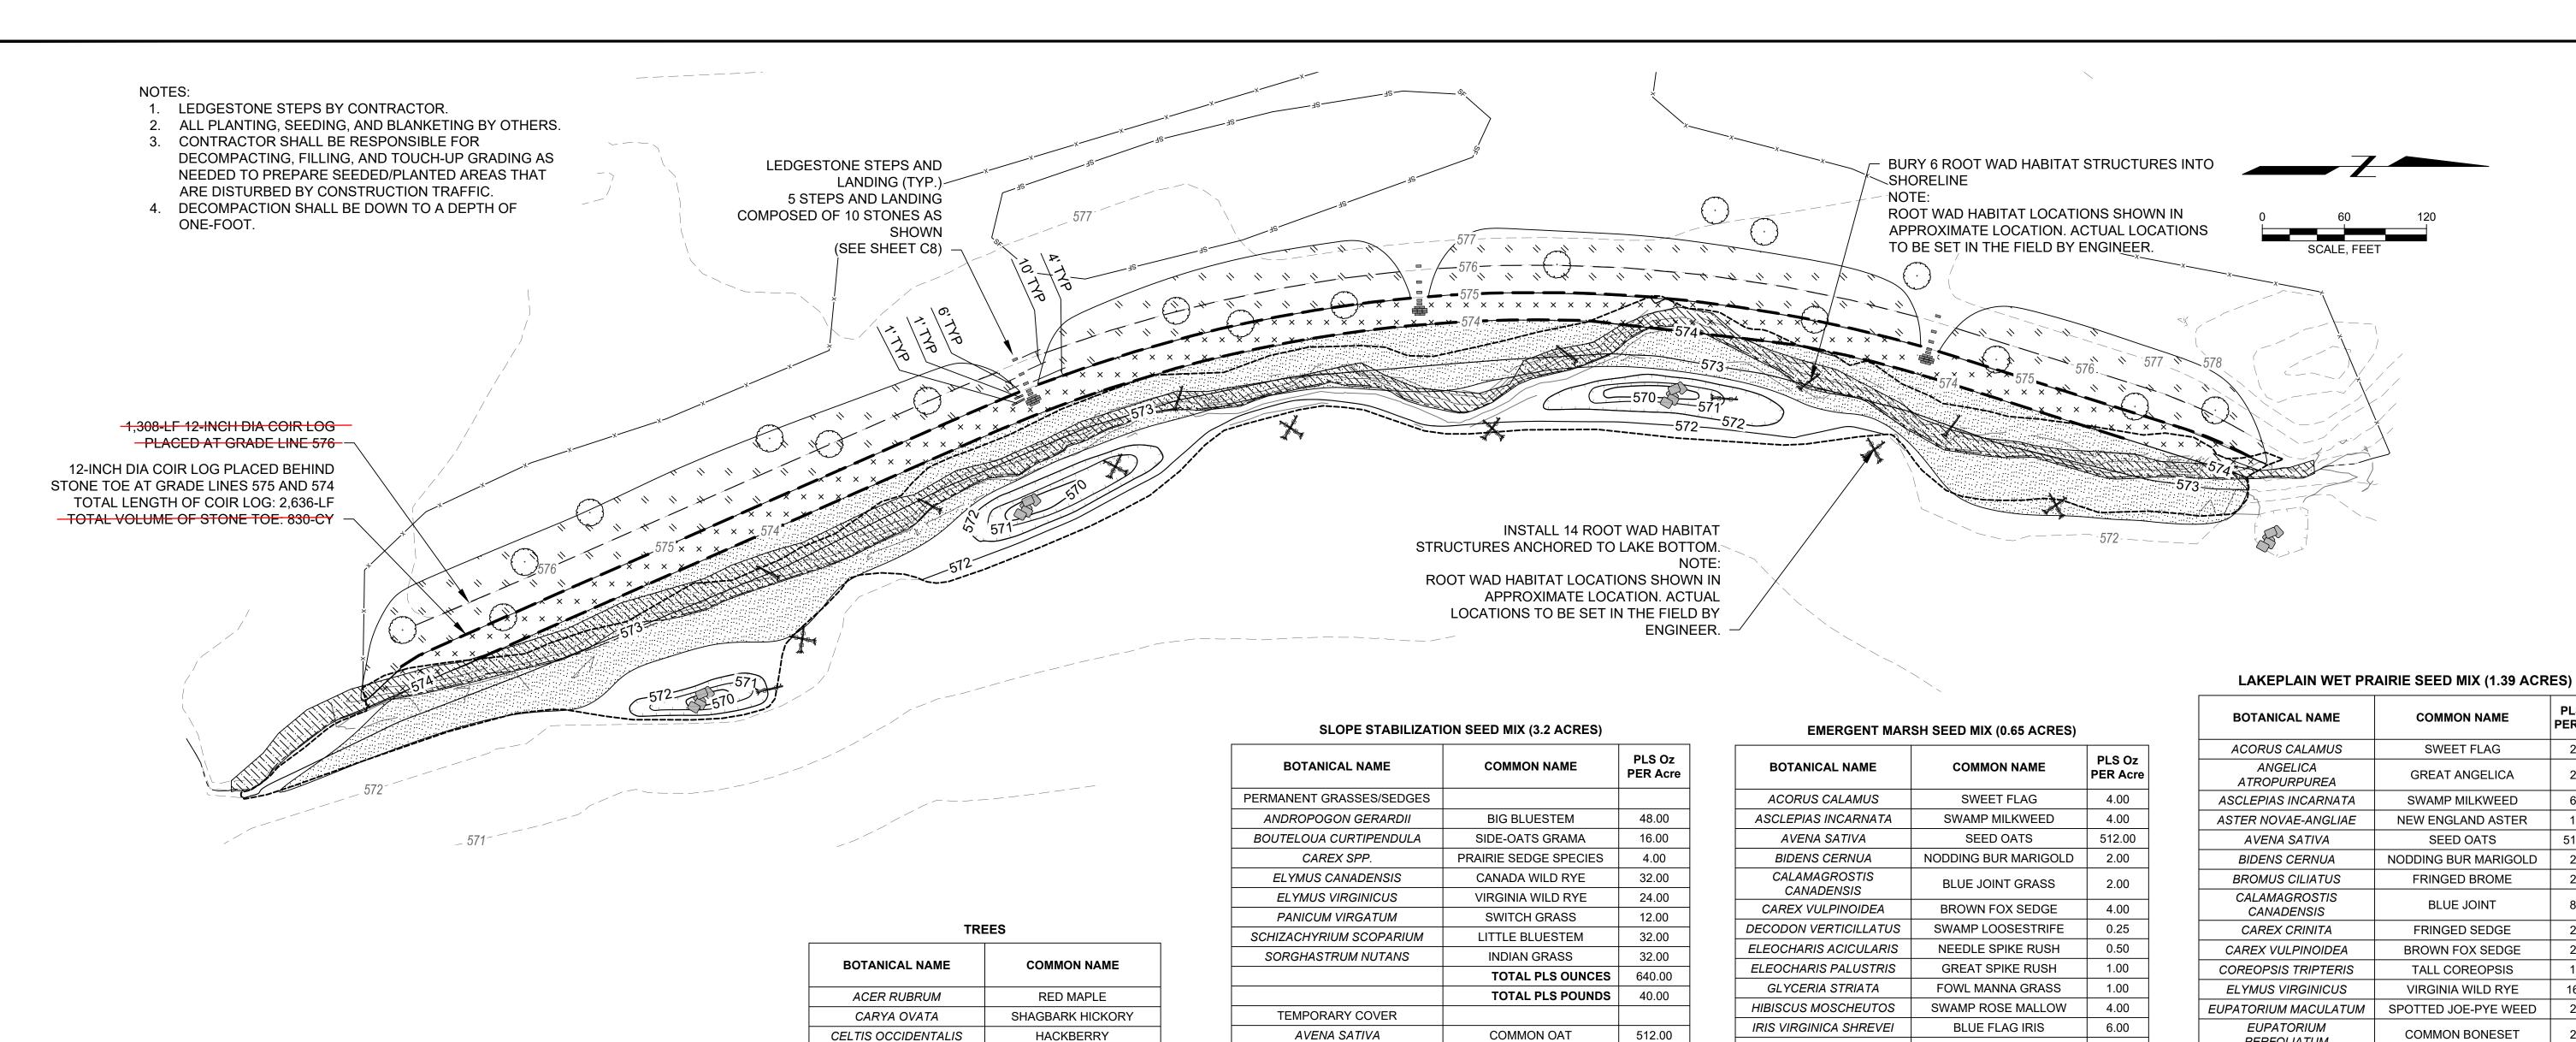
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AUTHORITI		SHEET NO.
	SITE DETAILS	8 of 10

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LOLIUM MULTIFLORUM

**BOTANICAL NAME** 

SCHOENOPLECTUS ACUTUS

SCHOENOPLECTUS PUNGENS

SCHOENOPLECTUS

TABERNAEMONTANI

CORNUS SERICEA

SALIX INTERIOR

WETLAND DELINEATION PR. MAJ. CONTOUR OHWM - 573.67PR. MIN. CONTOUR EX. MAJ. CONTOUR GRADING LIMITS -----

× × ×

× × ×

12" DIA COIR LOG

STONE TOE AND COIR \_\_\_\_ \_\_ \_\_ \_\_

PLANTING LEGEND

EMERGENT MARSH SEED MIX AREA ELEV. 574'-575' (0.65 AC)

EX. MIN. CONTOUR ———————

LAKEPLAIN WET PRAIRIE SEED MIX AREA ELEV. >575' (1.39 AC)

PLUG PLANTS AND LIVE STAKES ELEV. 572.5'-574' (1.58 AC)

PROPOSED TREE (18)

BOTANICAL NAME	COMMON NAME	
ACER RUBRUM	RED MAPLE	
CARYA OVATA	SHAGBARK HICKORY	
CELTIS OCCIDENTALIS	HACKBERRY	
NYSSA SYLVATICA	BLACK GUM	
PLATANUS OCCIDENTALIS	SYCAMORE	
QUERCUS BICOLOR	SWAMP WHITE OAK	

- 1. SEEDING AND PLANTING WILL BE SELF-PERFORMED BY HCMA. CONTRACTOR IS RESPONSIBLE FOR INSTALLING TOPSOIL AND DECOMPACTING ALL AREAS TO BE SEEDED AND PLANTED, INCLUDING
- 2. ALL SEEDED AREAS TO BE COVERED IN BIODEGRADABLE EROSION CONTROL BLANKET.
- 3. SEEDING AND BLANKETING PROJECTED DOWN TO ELEVATION ~ 574.0'
- 574.0'-575.0'.

5. LAKEPLAIN WET PRAIRIE SEED MIX TO BE INSTALLED ABOVE

4. EMERGENT MARSH SEED MIX TO BE INSTALLED FROM ELEVATION

- ELEVATION 575.0'. 6. PLUGS AND LIVE STAKES TO BE INSTALLED FROM ELEVATION 572.5'-574.0'. PLANTS TO BE INSTALLED INTO STONE MATRIX IN
- 7. TREES TO BE SELECTED FROM THE TREE LIST TABLE OR AS APPROVED BY PROJECT ENGINEER. NO INDIVIDUAL SPECIES CAN ACCOUNT FOR MORE THAN 33% OF THE TREES PROVIDED. INDIVIDUAL SPECIES MAY BE GROUPED IN 2-3 PER PLANTING OR INDIVIDUALLY, AND GROUPS SHALL BE MIXED THROUGHOUT THE
- 8. TREES TO BE MINIMUM 1.5" CAL. AT D.B.H. BALLED AND BURLAPPED.

CLUSTERS OF 12"-18" SPACING.

PLANTING AREA.

BOTANICAL NAME	COMMON NAME	PLS Oz PER Acre
ACORUS CALAMUS	SWEET FLAG	4.00
ASCLEPIAS INCARNATA	SWAMP MILKWEED	4.00
AVENA SATIVA	SEED OATS	512.00
BIDENS CERNUA	NODDING BUR MARIGOLD	2.00
CALAMAGROSTIS CANADENSIS	BLUE JOINT GRASS	2.00
CAREX VULPINOIDEA	BROWN FOX SEDGE	4.00
DECODON VERTICILLATUS	SWAMP LOOSESTRIFE	0.25
ELEOCHARIS ACICULARIS	NEEDLE SPIKE RUSH	0.50
ELEOCHARIS PALUSTRIS	GREAT SPIKE RUSH	1.00
GLYCERIA STRIATA	FOWL MANNA GRASS	1.00
HIBISCUS MOSCHEUTOS	SWAMP ROSE MALLOW	4.00
IRIS VIRGINICA SHREVEI	BLUE FLAG IRIS	6.00
JUNCUS CANADENSIS	CANADIAN RUSH	1.00
JUNCUS EFFUSUS	COMMON RUSH	3.00
JUNCUS TORREYI	TORREY'S RUSH	0.25
LEERSIA ORYZOIDES	RICE CUT GRASS	2.00
LOLIUM MULTIFLORUM	ANNUAL RYE	160.00
MIMULUS RINGENS	MONKEY FLOWER	1.00
PELTANDRA VIRGINICA	ARROW ARUM	6.00
PONTEDERIA CORDATA	PICKEREL WEED	4.00
RUMEX ORBICULATUS	GREAT WATER DOCK	1.00
SAGITTARIA LATIFOLIA	SAGITTARIA LATIFOLIA	2.00
SAURURUS CERNUUS	LIZARD'S TAIL	0.50
SCIRPUS ACUTUS	HARD-STEMMED BULRUSH	2.00
SCIRPUS ATROVIRENS	DARK GREEN RUSH	2.00
SCIRPUS CYPERINUS	WOOL GRASS	1.00
SCIRPUS FLUVIATILIS	RIVER BULRUSH	2.00
SCIRPUS PUNGENS	CHAIRMAKER'S RUSH	3.00
SCIRPUS VALIDUS	CREBER GREAT BULRUSH	4.00
SPARGANIUM EURYCARPUM	COMMON BUR REED	2.00
ZIZANIA AQUATICA	WILD RICE	32.00
	TOTAL PLS OUNCES	923.40
	TOTAL PLS POUNDS	57.70

ATROPURPUREA	GIVE/VI / IIVO ELIO/V	2.00
ASCLEPIAS INCARNATA	SWAMP MILKWEED	6.00
ASTER NOVAE-ANGLIAE	NEW ENGLAND ASTER	1.00
AVENA SATIVA	SEED OATS	512.00
BIDENS CERNUA	NODDING BUR MARIGOLD	2.00
BROMUS CILIATUS	FRINGED BROME	2.00
CALAMAGROSTIS CANADENSIS	BLUE JOINT	8.00
CAREX CRINITA	FRINGED SEDGE	2.00
CAREX VULPINOIDEA	BROWN FOX SEDGE	2.00
COREOPSIS TRIPTERIS	TALL COREOPSIS	1.00
ELYMUS VIRGINICUS	VIRGINIA WILD RYE	16.00
EUPATORIUM MACULATUM	SPOTTED JOE-PYE WEED	2.00
EUPATORIUM PERFOLIATUM	COMMON BONESET	2.00
GLYCERIA STRIATA	FOWL MANNA GRASS	2.00
HIBISCUS MOSCHEUTOS	SWAMP ROSE MALLOW	2.00
IRIS VIRGINICA SHREVEI	BLUE FLAG IRIS	5.00
JUNCUS EFFUSUS	COMMON RUSH	2.00
LEERSIA ORYZOIDES	RICE CUT GRASS	2.00
LIATRIS SPICATA	MARSH BLAZING STAR	2.00
LOBELIA CARDINALIS	CARDINAL FLOWER	1.00
LOBELIA SIPHILITICA	GREAT BLUE LOBELIA	1.00
LOLIUM MULTIFLORUM	ANNUAL RYE	160.00
MIMULUS RINGENS	MONKEY FLOWER	2.00
MONARDA FISTULOSA	WILD BERGAMOT	2.00
PYCNANTHEMUM VIRGINIANUM	COMMON MOUNTAIN MINT	1.00
ROSA PALUSTRIS	SWAMP ROSE	1.00
SAGITTARIA LATIFOLIA	COMMON ARROWHEAD	1.00
SCIRPUS ATROVIRENS	DARK GREEN RUSH	1.00
SCIRPUS CYPERINUS	WOOL GRASS	1.00
SOLIDAGO OHIOENSIS	OHIO GOLDENROD	1.00
SPARTINA PECTINATA	PRAIRIE CORD GRASS	10.00
THALICTRUM DASYCARPUM	PURPLE MEADOW RUE	0.50
	-	

PLS Oz

PER Acre

2.00

2.00

# FOR CONSTRUCTION

TOTAL PLS OUNCES

TOTAL PLS POUNDS 90.43

2.00

2.00

1446.85

BLUE VERVAIN

GOLDEN ALEXANDERS



#### Warning:

It is a violation of Section 7209.2 of the New York State Education Law for any person, unless acting under the direction of a licensed professional engineer, to alter in any way plans, specifications, plats or reports to which the seal of a professional engineer has been applied. If an item bearing the seal of a professional engineer is altered, the altering engineer shall affix to the item his seal and the notation "Altered By" followed by his signature, the date, and a specific description of the alteration.

6/2/2022 | PERMIT SET Attention: ISSUED FOR BIDDING 10/10/2022 | ISSUED FOR BIDDING If this scale bar does not measure I" then drawing is not original scale. NO. DATE APP ISSUE/REVISION

Designed:	MS
Checked:	SD
Drawn:	MS, HC
Submitted By:	SD
P.E. Number:	44371

ANNUAL RYE

**COMMON NAME** 

HARDSTEM BULRUSH

THREESQUARE

SOFTSTEM BULRUSH

RED OSIER DOGWOOD

SANDBARK WILLOW

**TOTAL** 

PLUG PLANTS AND LIVE STAKES (1.58 ACRES)

TOTAL PLS OUNCES

TOTAL PLS POUNDS

240.00

2406.40

QTY

1000

1500

1000

750

750





HURON-CLINTON METROPARK	
AUTHORITY	


GEI Project 1903754

LAKE ERIE METROPARK SHORELINE RESTORATION	DWG. NO. <b>C7</b>
	SHEET NO.
SHORELINE PLANTING PLAN	9 of 10

\\ALL-PZCC-1\ K:\Huron-ClintonMetroAuthority\1903754\_Lake Erie Shoreline Restoration\CAD\06012022\_Shoreline Restoration Ph.2\20220630\_ERIE PR.dwg - 10/10/2022

VERBENA HASTATA

ZIZIA AUREA

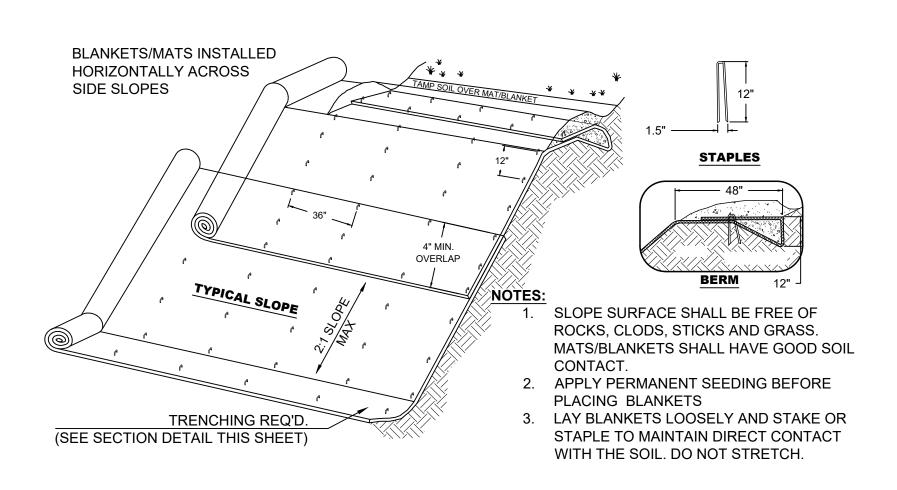


D50 5-INCH STONE

LAKE BOTTOM

# **EROSION CONTROL BLANKET**


NOT TO SCALE (BY OTHERS)

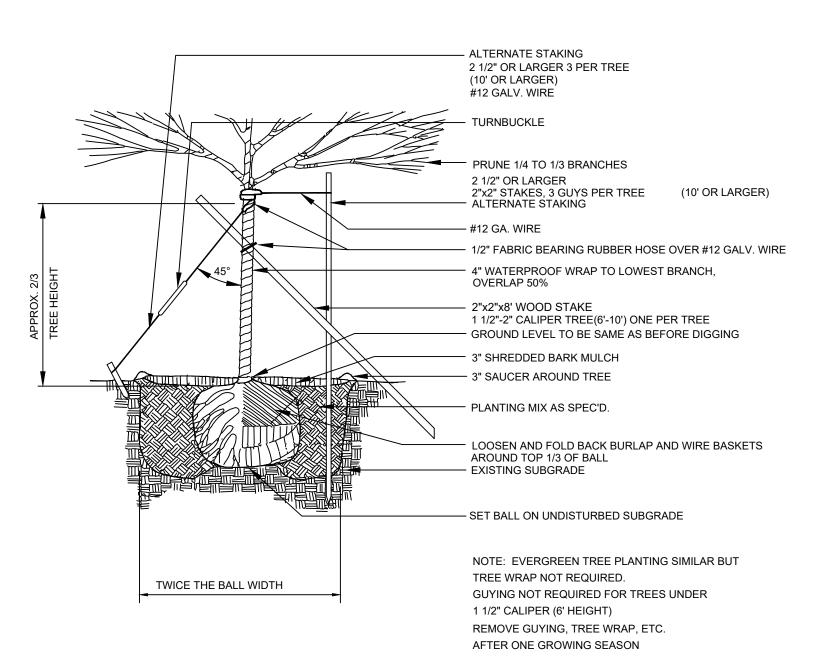

# BALLED AND BURLAPPED (B&B) TREE PLANTING

NOT TO SCALE (BY OTHERS)

INSTALL LIVE STAKES AND PLUGS IN

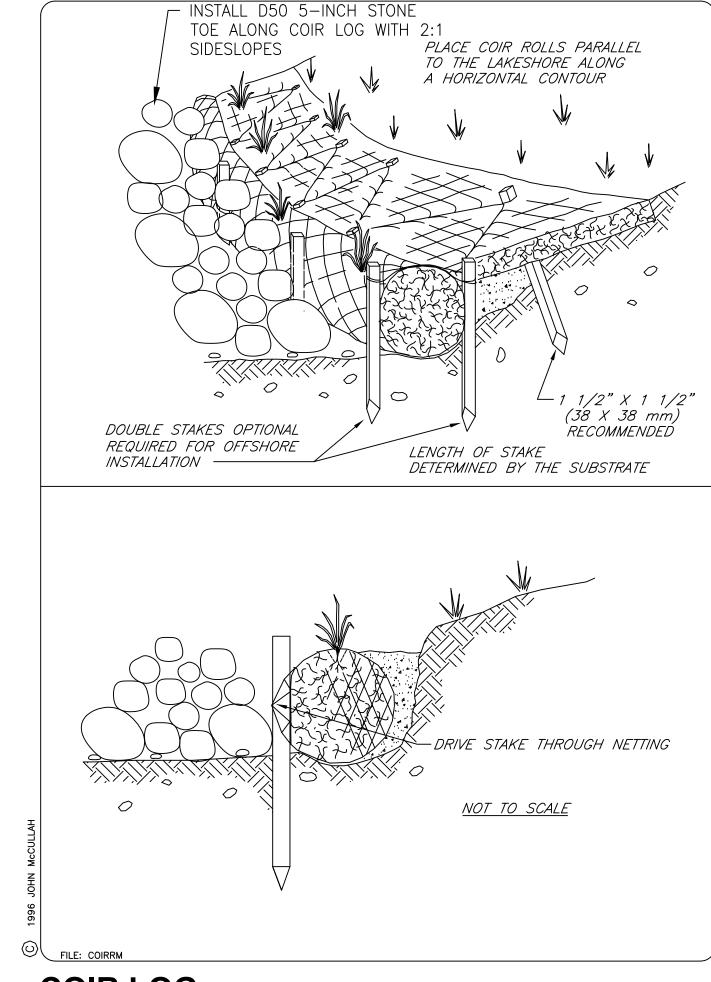


### **COIR LOG** NOT TO SCALE

(BY OTHERS)

CLUSTERS OF 12-INCH TO 18-INCH SPACING BETWEEN ROCK SUBSTRATE

## PLUG AND LIVE STAKE PLANTING

NOT TO SCALE

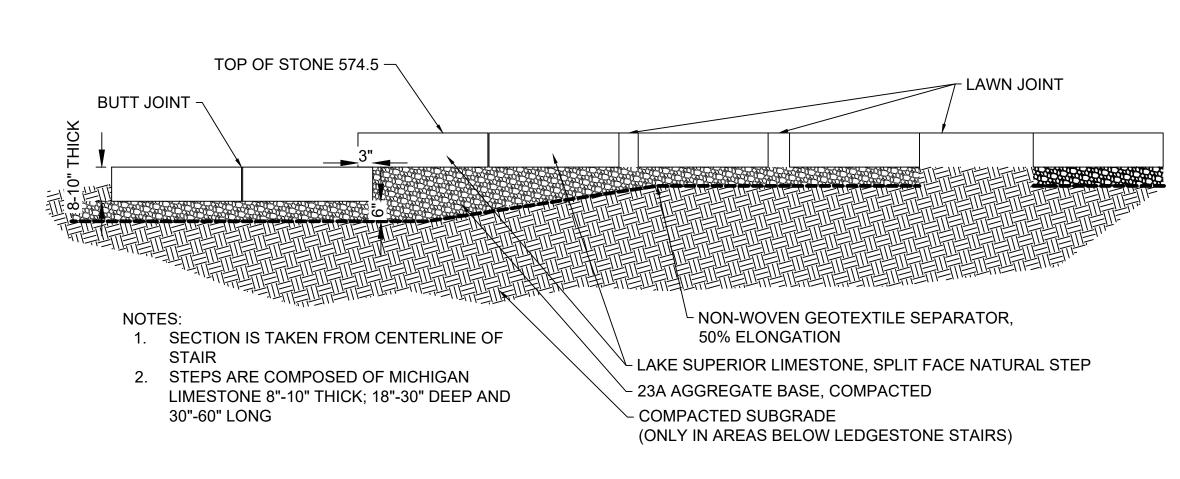

## LEDGESTONE STEPS AND LANDING

NOT TO SCALE

# FOR CONSTRUCTION



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A44 12	1	6/2/2022	PERMIT SET	
Attention:	2	7/1/2022	ISSUED FOR BIDDING	
0 1"	3	10/10/2022	ISSUED FOR BIDDING	
If this scale bar				
does not measure 1" then drawing is				
not original scale.	NO.	DATE	ISSUE/REVISION	APP

Designed:	MS	
Checked:	SD	
Drawn:	MS, HC	
Submitted By:	SD	
P.E. Number:	44371	



HURON-CLINTON METRO
AUTHORITY

ON-CLINTON METROPARK AUTHORITY	LAKE ERIE METROPARK SHORELINE RESTORATION	DWG. NO.
	LANDSCAPE DETAILS	SHEET NO.
		10 of 10
GEI Project 1903754		